DENILIQUIN MICRO SOLAR FARM

LANDSCAPE DOCUMENTATION

CLIENT

Chris Smith

Chris Smith Associates

Level 1, 135 Fryers St Shepparton VIC 3630

Green Gold Energy

Level 17, 570 Bourke St Melbourne VIC 3000

PREPARED BY



Landscape Architect Urban Initiatives

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DRAWING REGISTER

| Drawing List | | | | | | | | |
|----------------------|-----------------------------|--|--|--|--|--|--|--|
| Sheet No. Sheet Name | | | | | | | | |
| LD0.0 | Cover Page | | | | | | | |
| LD0.1 | Legend | | | | | | | |
| LD0.2 | Site Plan | | | | | | | |
| LD1.1 | Existing Conditions Photos | | | | | | | |
| LD2.1 | Site Montage View 1 | | | | | | | |
| LD2.2 | Site Montage View 2 | | | | | | | |
| LD2.3 | Site Montage View 3 | | | | | | | |
| LD2.4 | Site Montage View 4 | | | | | | | |
| LD2.5 | Site Montage View 5 | | | | | | | |
| LD3.1 | Planting Plan A | | | | | | | |
| LD3.2 | Planting Plan B | | | | | | | |
| LD3.3 | Planting Plan C | | | | | | | |
| LD3.4 | Planting Schedule & Details | | | | | | | |



DESIGN STATEMENT

The following landscape plans and associated planting schedule have been prepared to ensure the integration of the proposed Deniliquin Micro Solar Farm within the existing site context and landscape character.

The 14.3Ha site is well suited to the proposed solar farm. It is situated on a large, flat block with excellent solar orientation, some nearby adjoining neighbours, extensive setbacks and a moderate level of exposure to the surrounding rural roads to the north, east, and west. The existing trees within the property at the eastern end and the neighbouring property to the immediate northwest provide sufficient screening on those interfaces. A moderate earth bund and existing road verge trees along Flanagans Lane on the boundary of the neighbouring property in the north and northeast assist in providing additional screening.

The proposed approach to the landscape integration of the proposed facility is based on the establishment of a continuous band of high quality landscape screening to the eastern, northern, western and southern boundaries. This would comprise a mix of indigenous screen shrubs which includes a variety of hardy and fast growing species which are suited to the local soil and environmental conditions.

The plants will be sourced from a local nursery and propagated from local provenance stock. Four species mixes have been developed to provide visual interest and variety in foliage type, flowering times, growth heights, etc. Species have been selected with careful consideration of the habit, growth rate etc, to provide a dense screen of three layers of plants proposed within a 5m wide band on the boundaries closest to residential properties and public road ways, and two layers of plants are proposed within a 2m wide band on boundaries facing broad distances to the nearest public road ways and residential properties. Larger pot sized screen plants (including Brachychiton) will be planted in the areas which are closest to the existing residences to provide denser screening. Visual presentations have been prepared to illustrate the effect of the screen planting, including project growth rates to. A high level of screening should be able to be established within three years, with the facility effectively fully screened in around five years.


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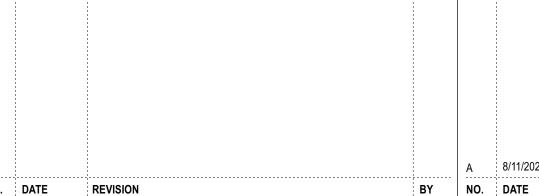


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NORTH

23041 Deiniliquin Micro Solar Farm

PROJECT

LD0.0

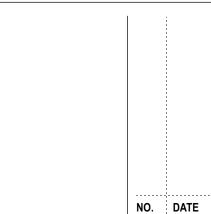DRAWING NAME **Cover Page**

39 Hogans Lane, Deniliquin, NSW 2710

LEGEND

GENERAL

Extent Of Works

—·—· Site Boundary

OVERALL

Screen Planting



Advanced Species Planting



Overhead Power Line Buffer

PLANTING

Mix A

Mix B

Mix C

Mix D - Low growing to 3m max height

Screening Plant Arrangement


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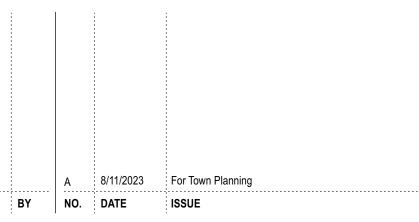
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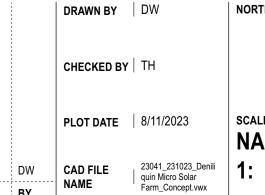
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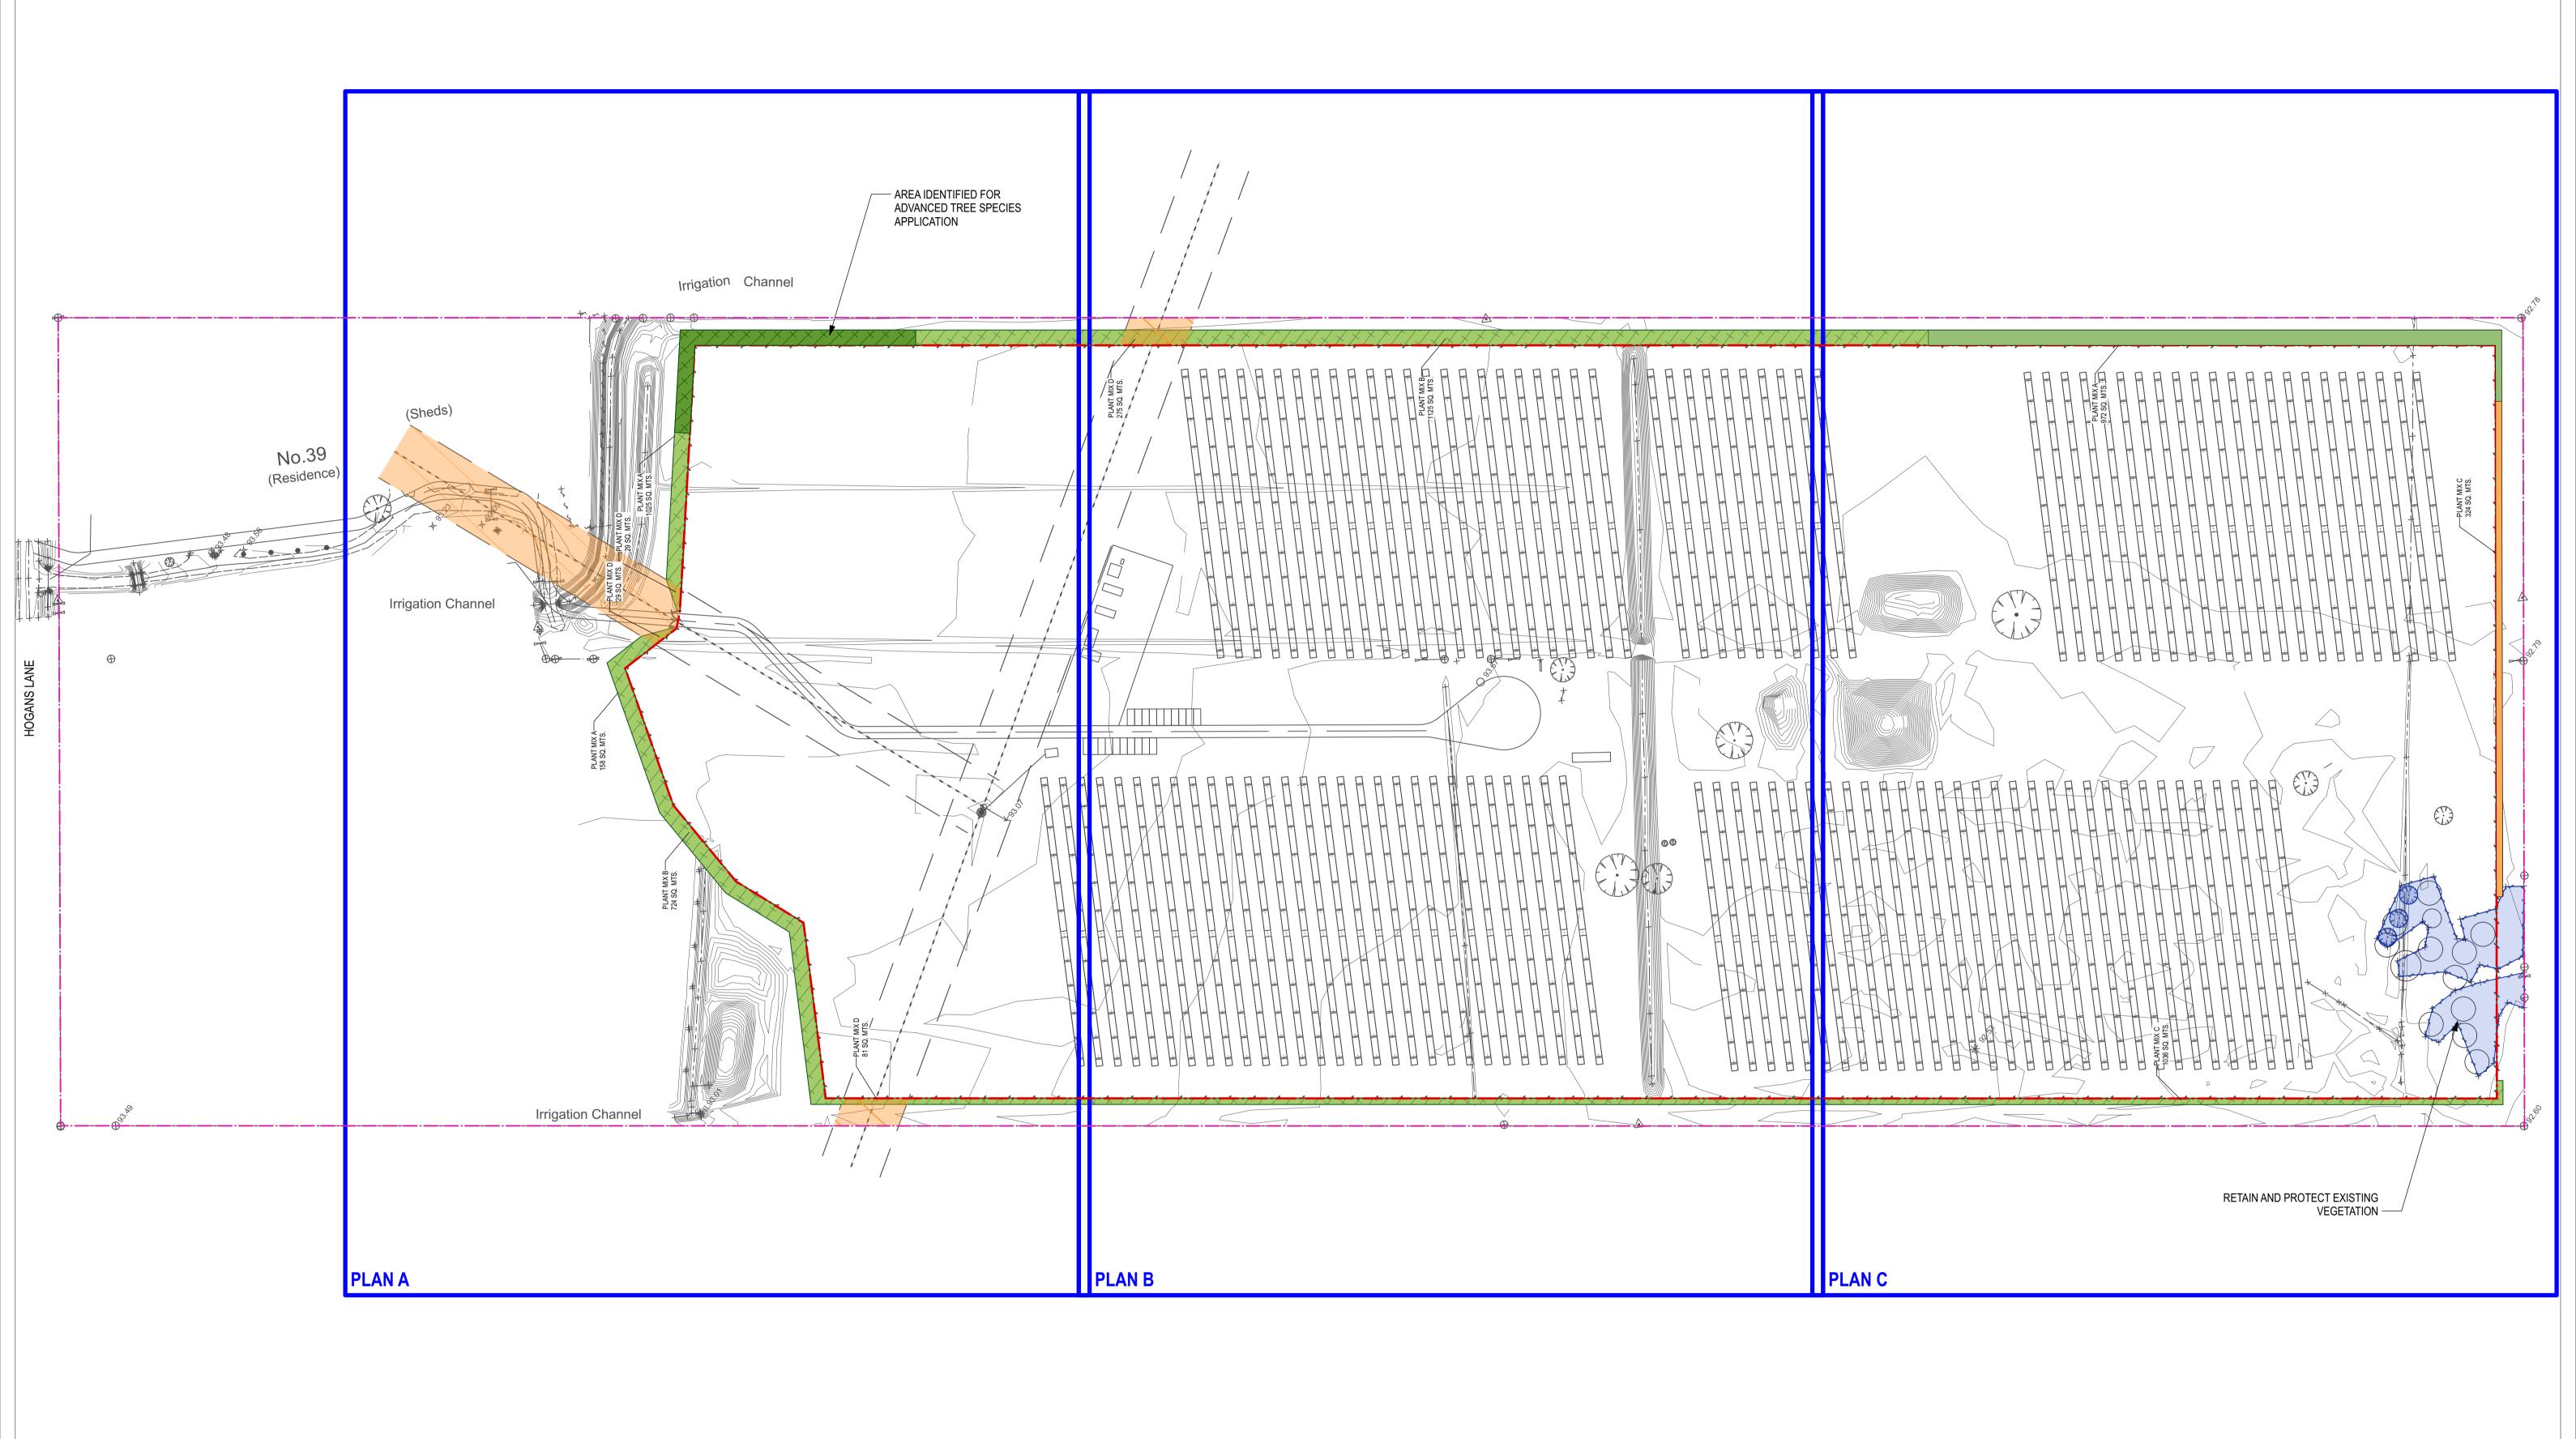



NORTH SCALE

PROJECT **23041 Deiniliquin Micro Solar Farm** @A1 address 39 Hogans Lane, Deniliquin, NSW 2710

DRAWING NO. LD0.1

DRAWING NAME Legend

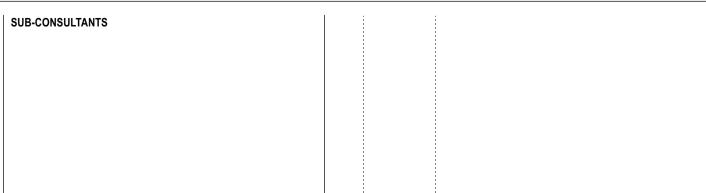

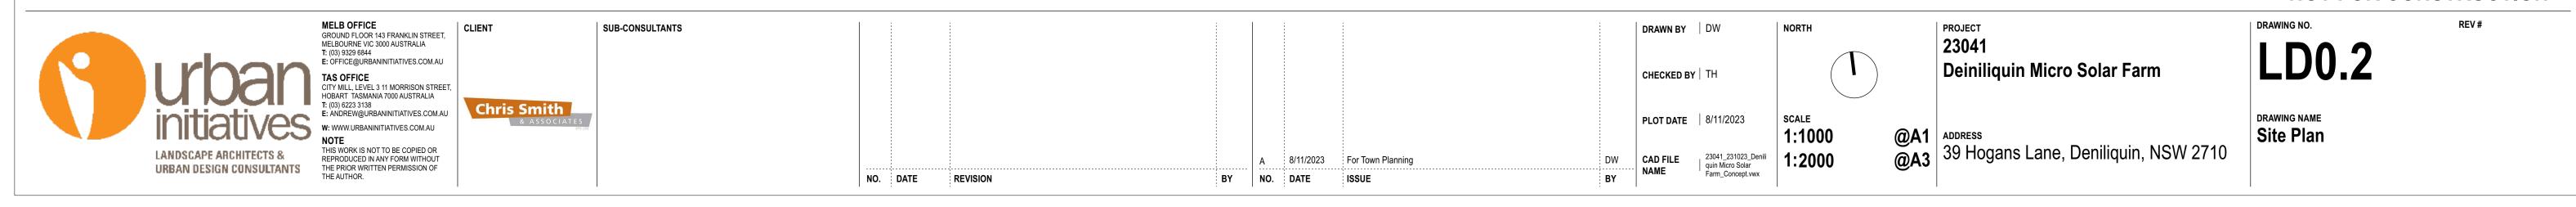



Within 39 Hogans Lane - Northwest corner- West towards East



2 Hogans Lane - South towards Northeast



3 Hogans Lane - West towards East



4 Flanagans Lane - North towards South



5 Flanagans Lane - East towards West






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NORTH

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@A1@A3ADDRESS39 Hogans Lane, Deniliquin, NSW 2710

LD1.1

DRAWING NAME
Existing Conditions Photos

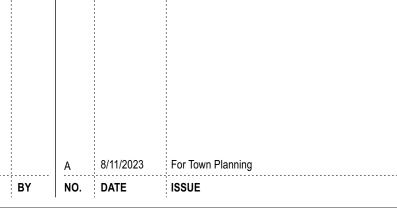

Within 39 Hogans Lane - Northwest cornerWest towards East



View at 5 years growth





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SCALE CAD FILE 23041_231023_Denili quin Micro Solar Farm_Concept.vwx

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LD2.1





View at 5 years growth

2 Hogans Lane - South towards Northeast





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SCALE

NORTH

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LD2.2







View at 5 years growth



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LD2.3



View at 5 years growth





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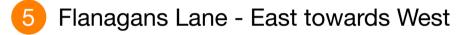
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LD2.4







View at 5 years growth



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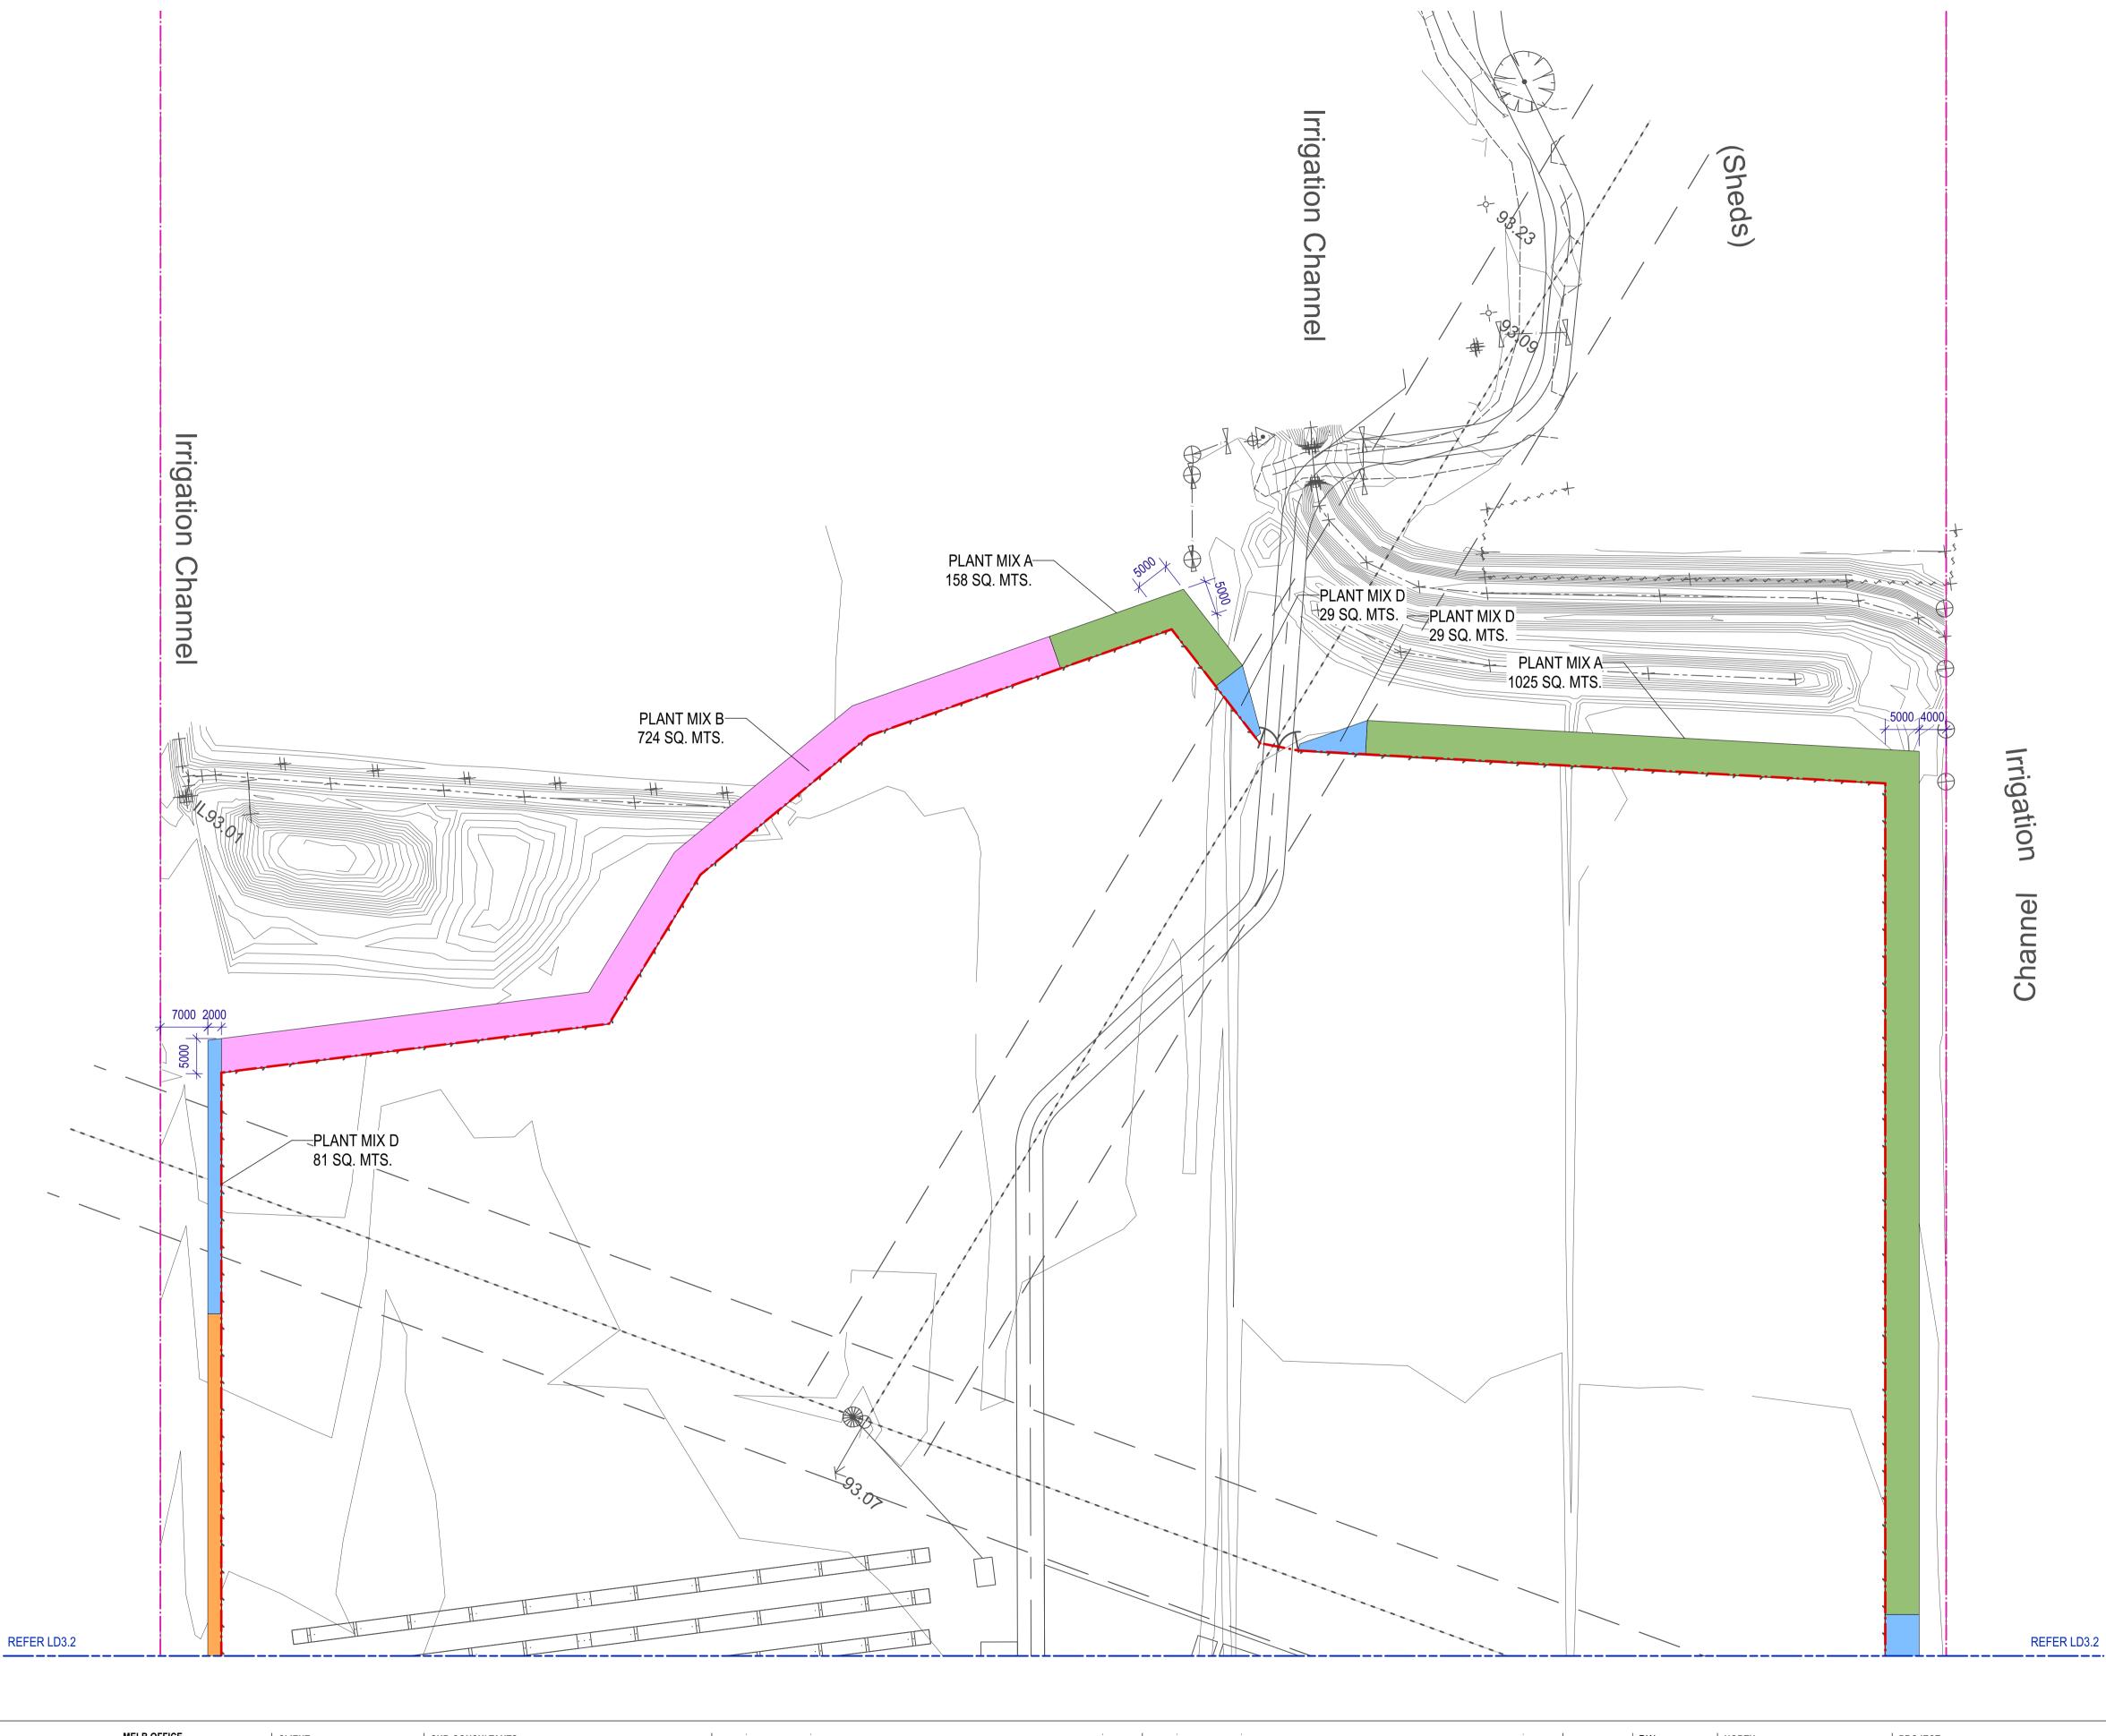
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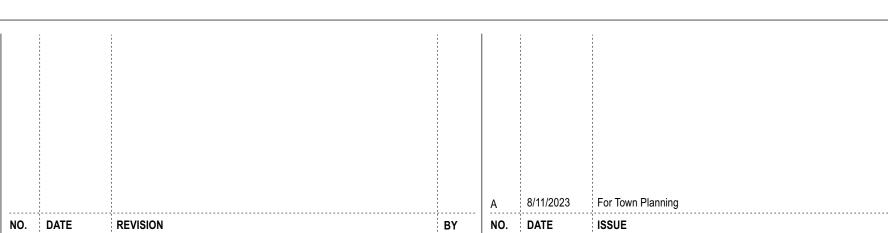




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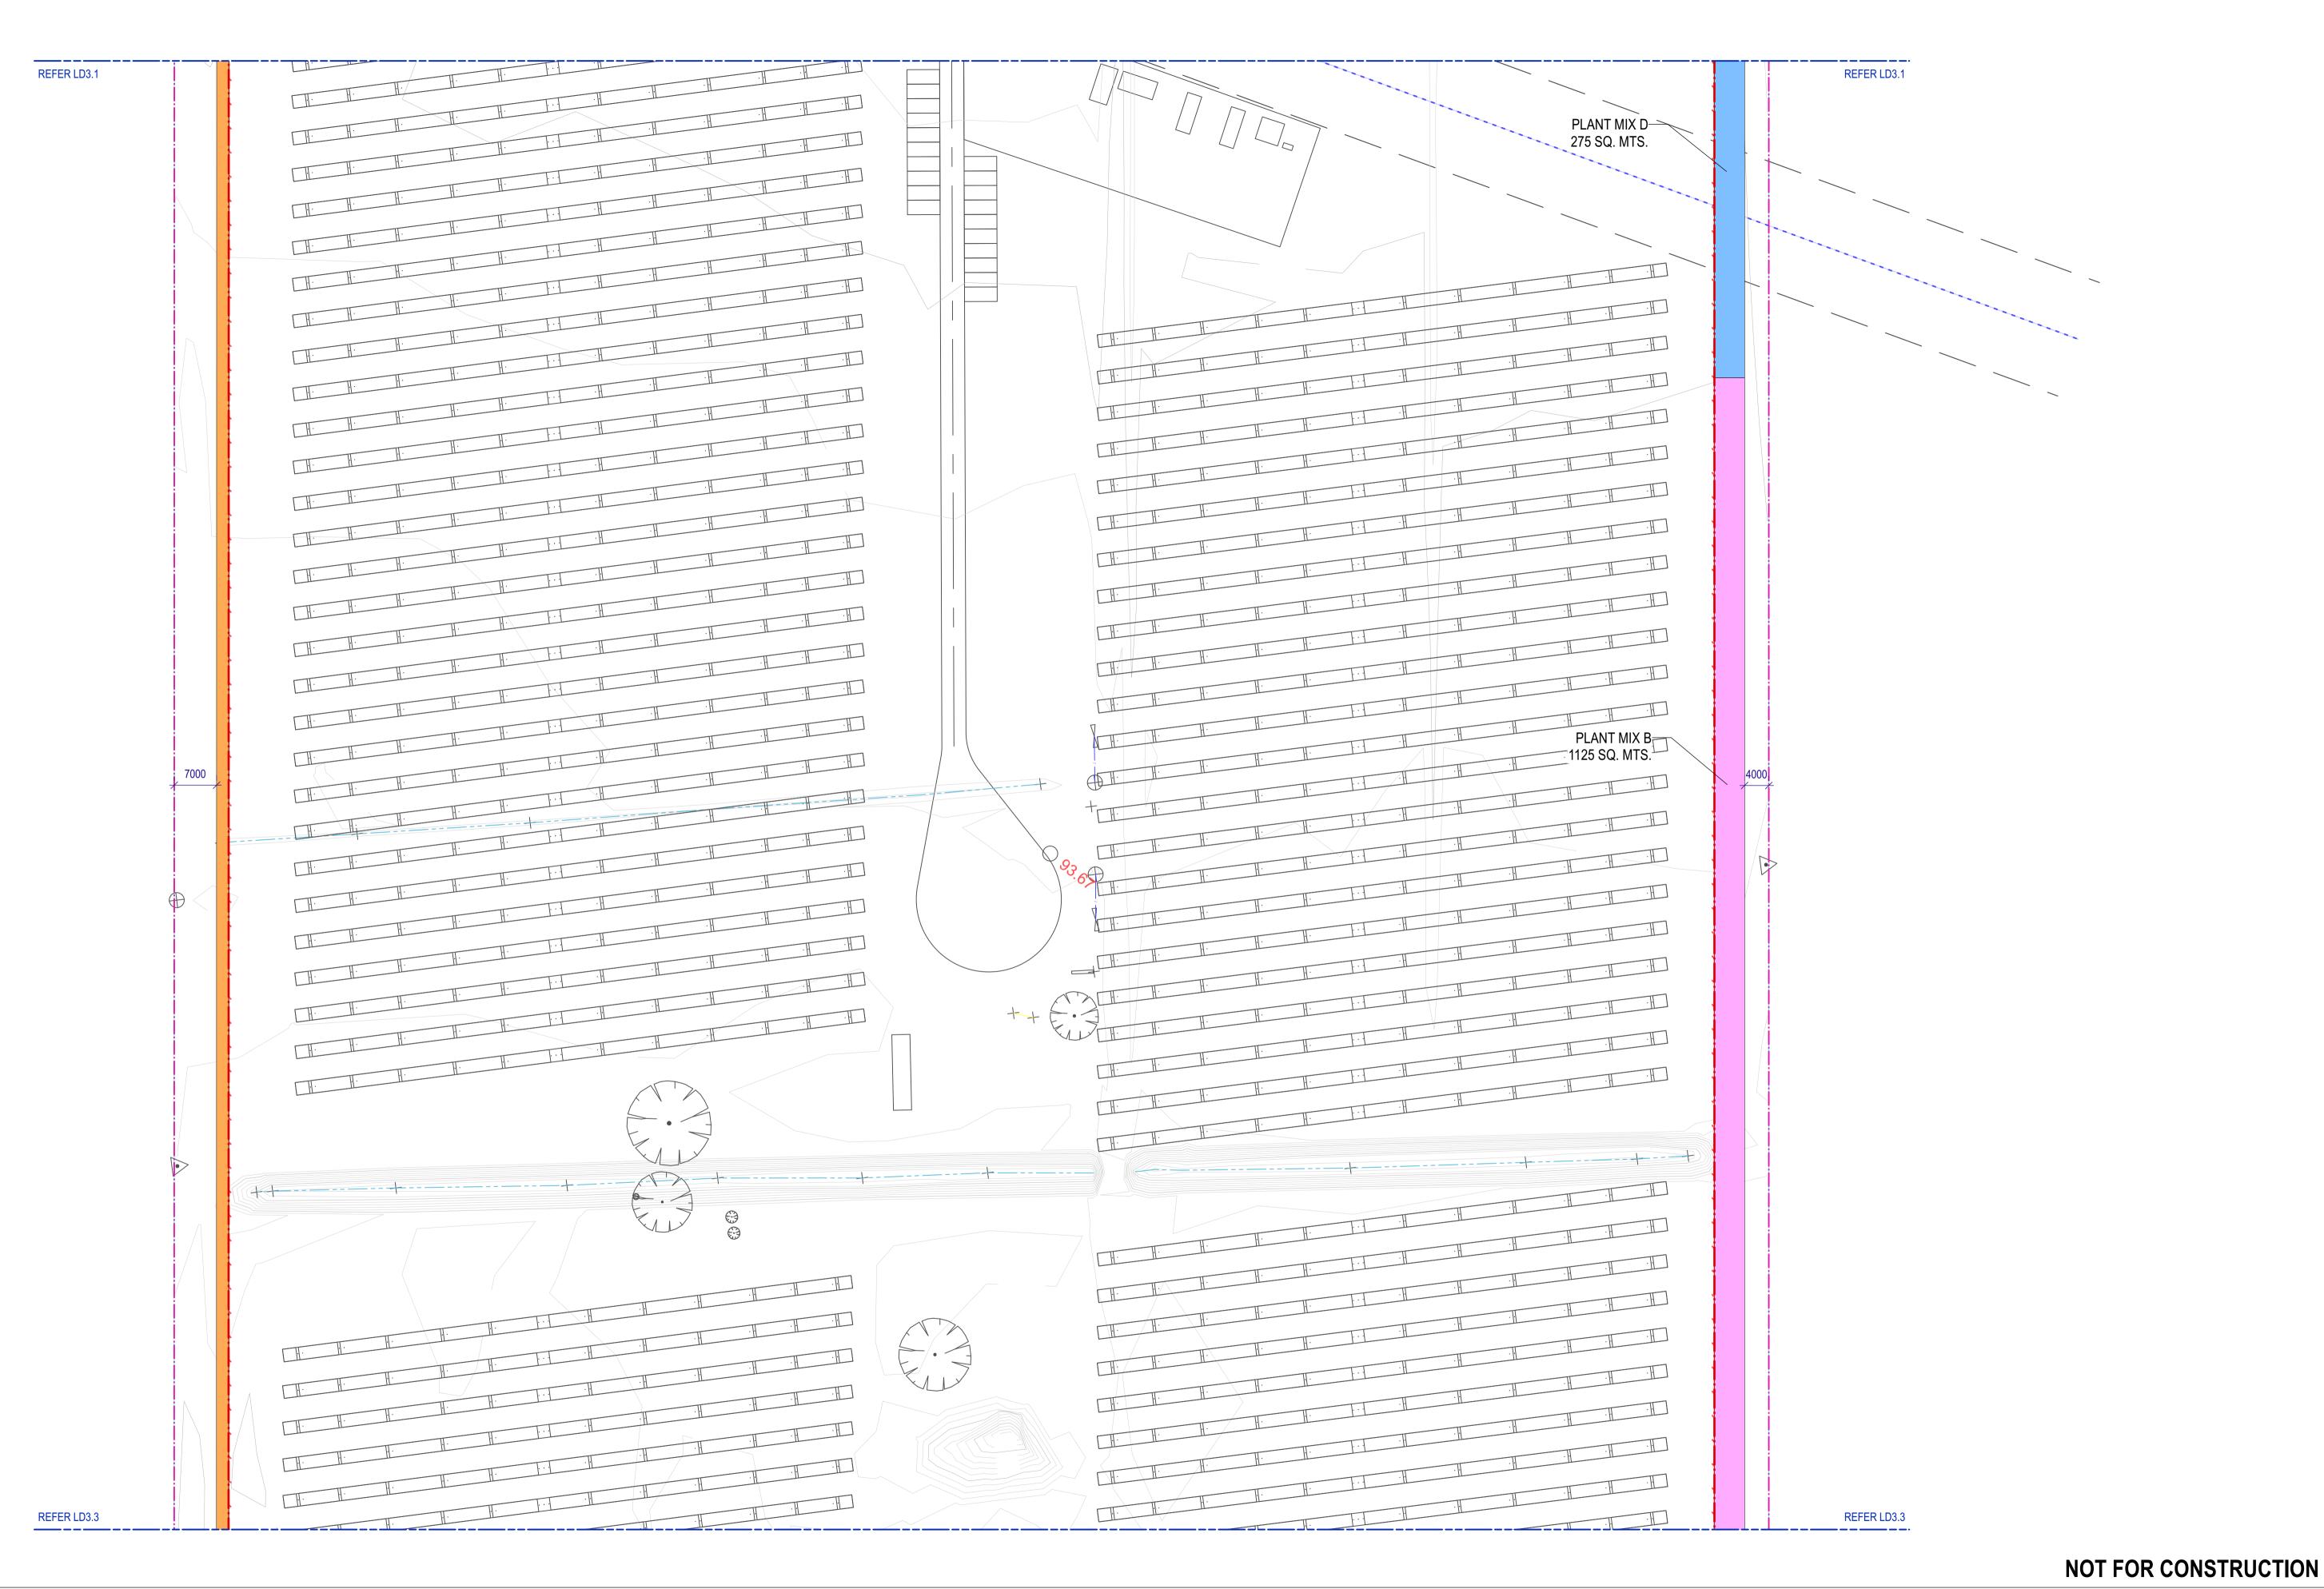
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PROJECT 23041 **Deiniliquin Micro Solar Farm**

Planting Plan A

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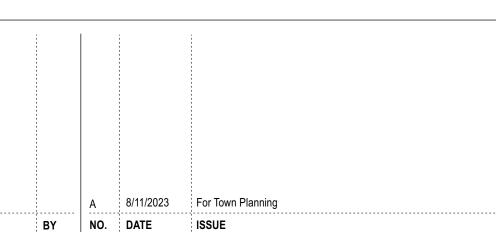
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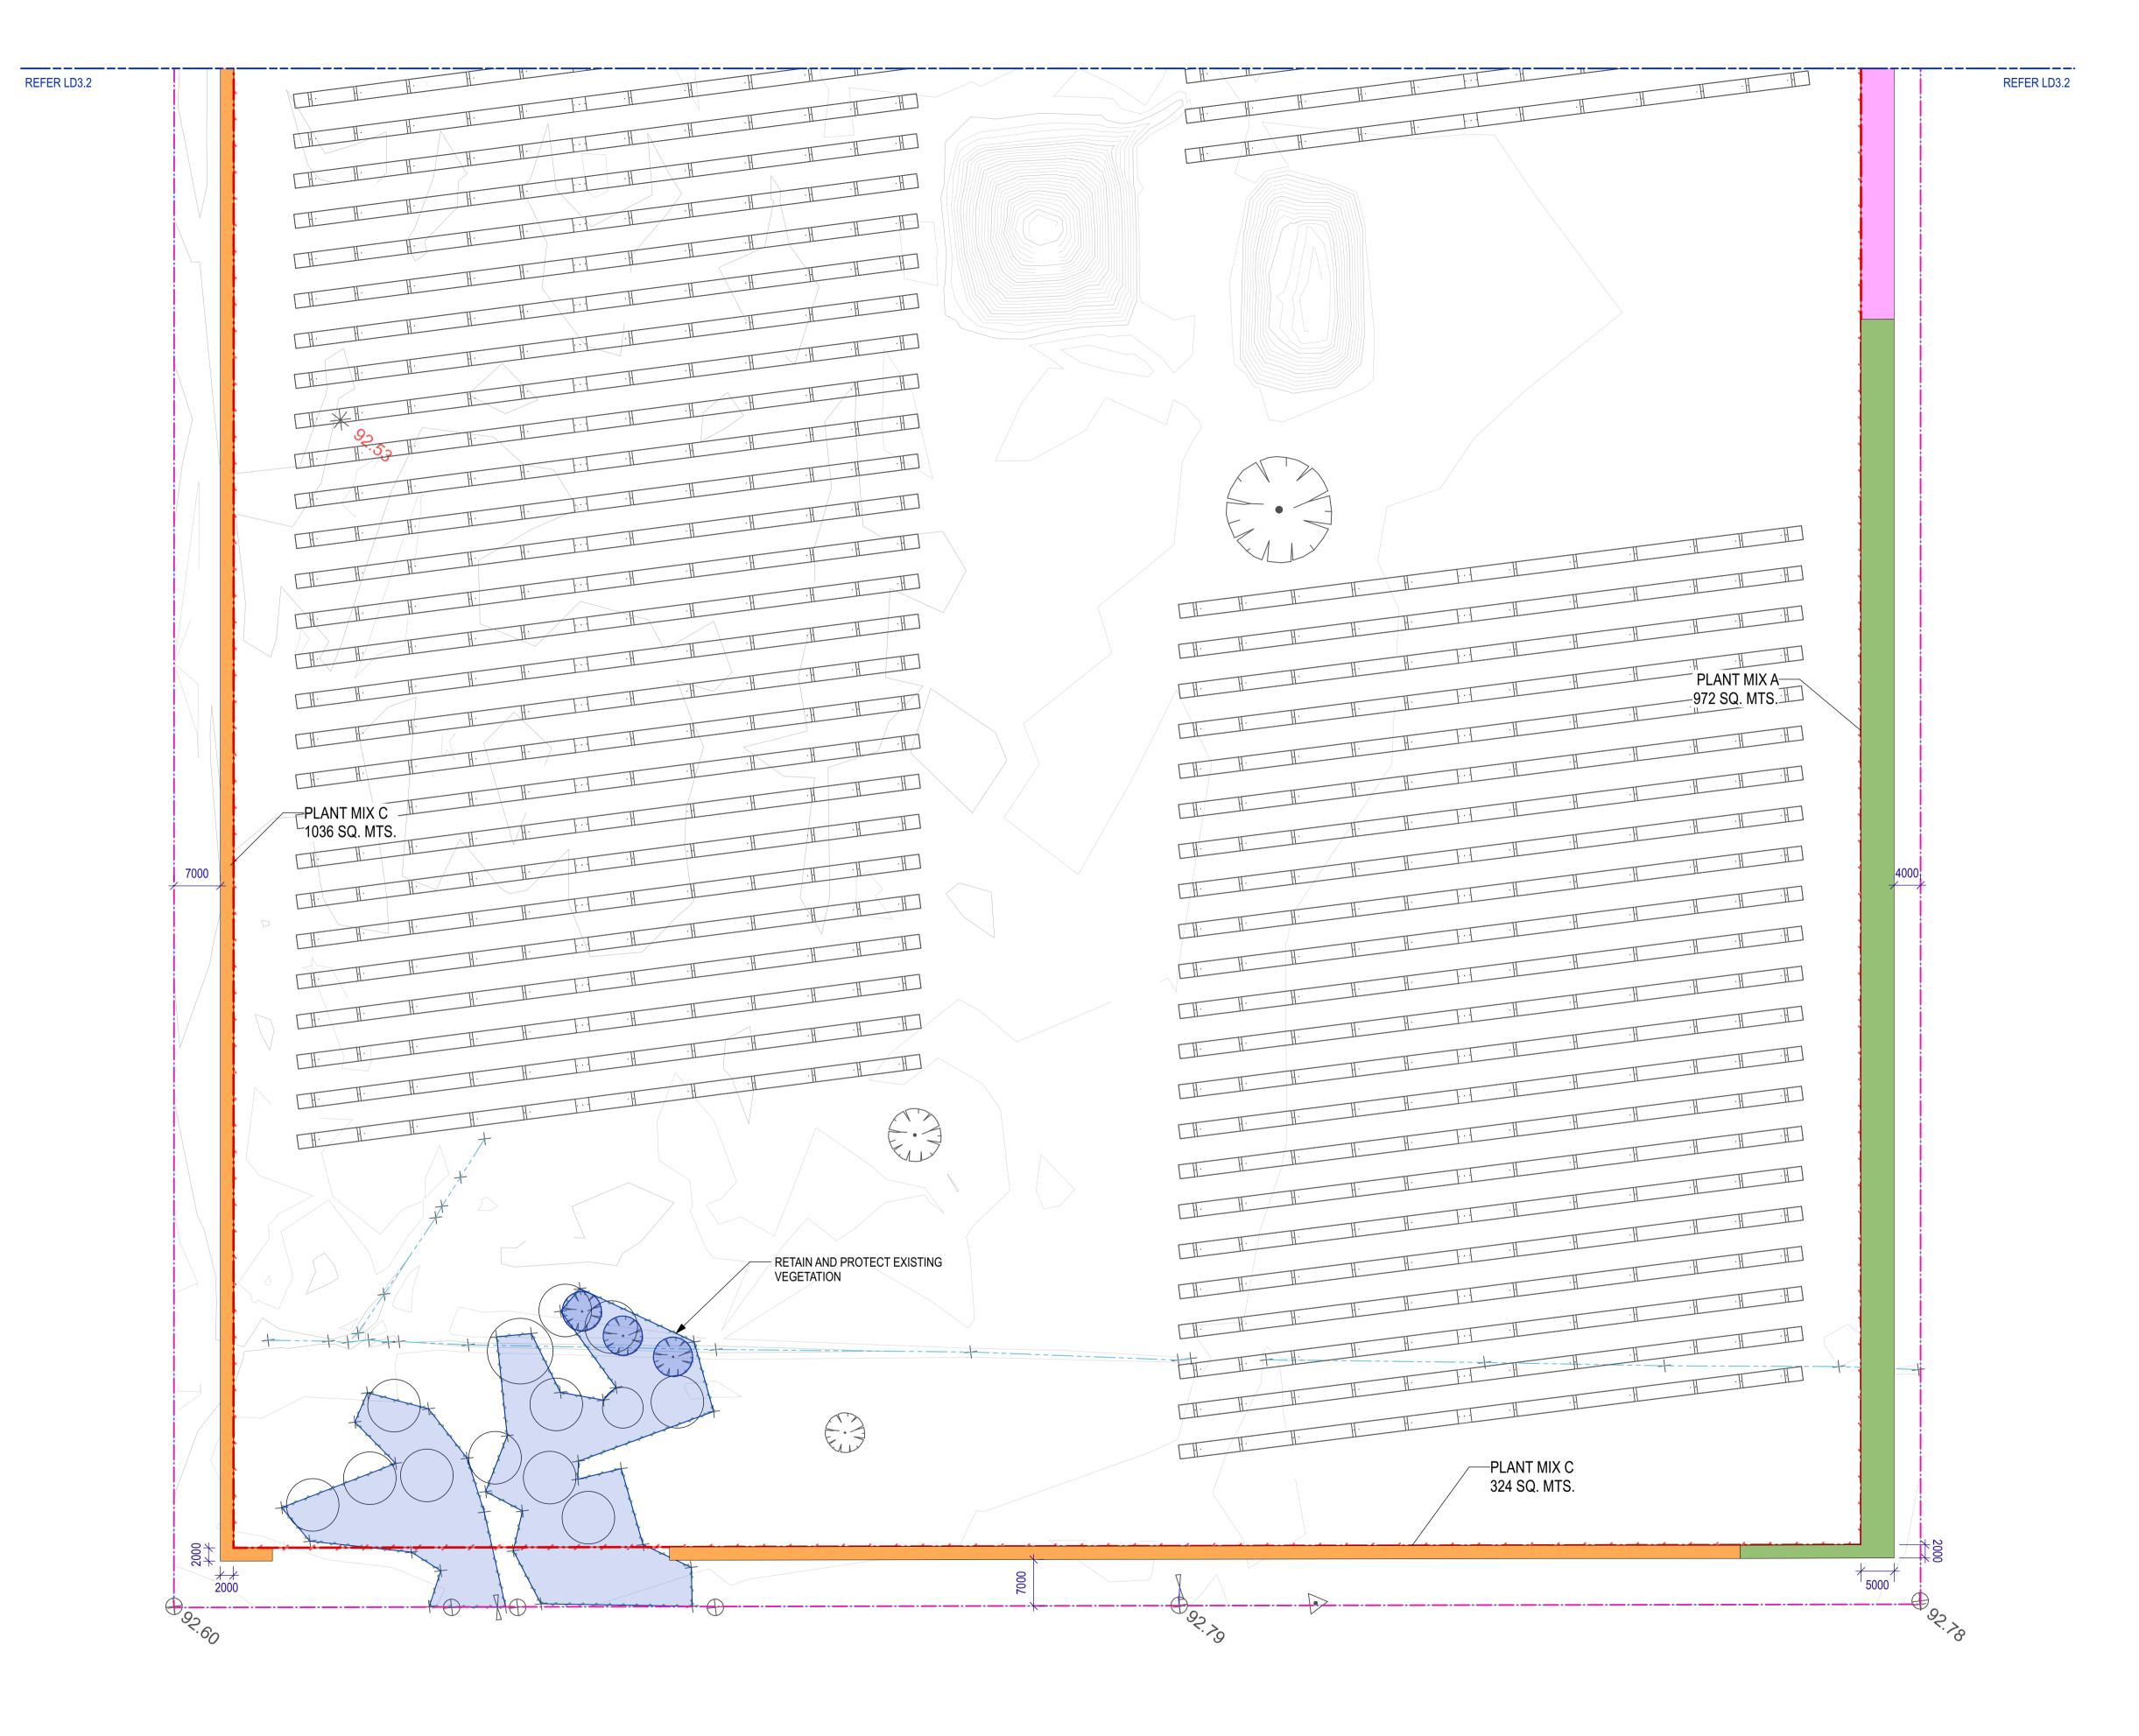
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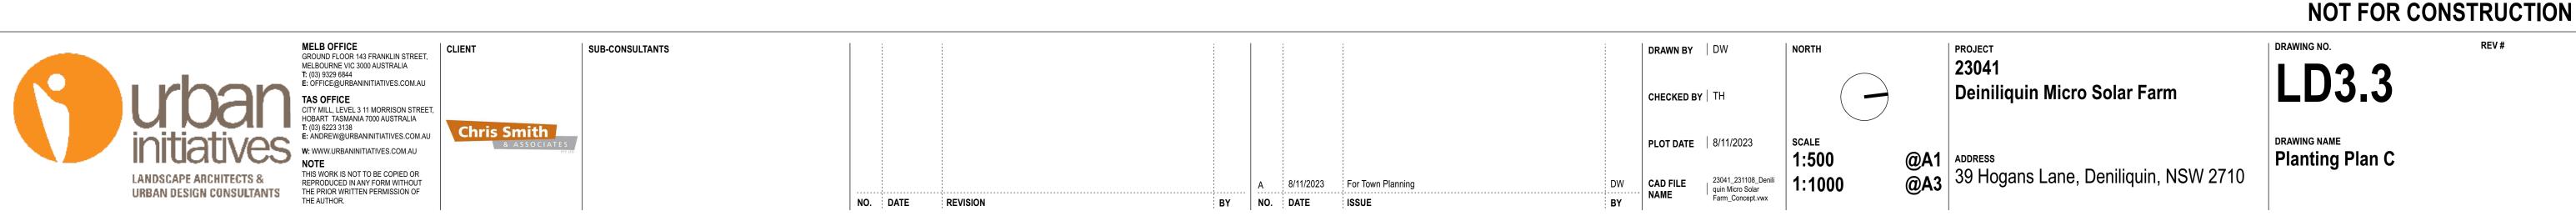
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PROJECT 23041 39 Hogans Lane, Deniliquin, NSW 2710


Deiniliquin Micro Solar Farm

Planting Plan B





| PI ANT S | PLANT SCHEDULE | | | | | | | | | | | | |
|----------|---------------------------------------|---------------------------|--------------------------|----------------|-------------------------------------|---------|----------------------|---------------------|---------------------|---------------------|---------------------|---------------------|--|
| Code | Botanical Name | Common Name | Included in Plant mix | Supply size | Approx Mature Size (HxW) m | Density | Typical tree spacing | Quantity / mix A | Quantity / mix B | Quantity / mix C | Quantity / mix D | Quantity / TOTAL | |
| | Shade/Structural Trees | | | | | | | | | | | | |
| Aca imp | Acacia implexa | Lightwood | Mix A | tube | 8 x 7 | 1/m2 | 3 mt c's | 130 | | | | 130 | |
| All lue | Allocasuarina luehmannii | Buloke | Mix C | tube | 15 x 10 | 1/m2 | 5 mt c's | | | 68 | | 68 | |
| Bra pop | Brachyiton populneus | Kurrajong | Mix A | 30cm | 15 x 8 | 1/m2 | 3 mt c's | 130 | | | | 130 | |
| Cal gla | Callitris glaucophylla | White cypress pine | Mix C | tube | 15 x 8 | 1/m2 | 3 mt c's | | | 68 | | 68 | |
| Cal gra | Callitris gracilis subsp. murrayensis | Murray cypress pine | Mix C | tube | 10 x 7 | 1/m2 | 3 mt c's | | | 68 | | 68 | |
| Euc leu | Eucalyptus leucoxylon-rosea | Pink flowering gum | Mix A & B | tube | 8 x 6 | 1/m2 | 3 mt c's | 130 | 111 | | | 241 | |
| Euc mel | Eucalyptus melliodora | Yellow Box | Mix B & C | tube | 25 x 15 | 1/m2 | 5 mt c's | | 111 | 68 | | 179 | |
| Euc mic | Eucalyptus microcarpa | Grey Box | Mix B | tube | 25 x 15 | 1/m2 | 5 mt c's | | 111 | | | 111 | |
| Euc sid | Eucalyptus sideroxylon-rosea | Red flowered ironbark | Mix A & B | tube | 15 x 10 | 1/m2 | 5 mt c's | 130 | 111 | | | 241 | |
| Euc spa | · · · · · · · · · · · · · · · · · · · | Swamp mallee | Mix C & A | tube | 8 x 6 | 1/m2 | 3 mt c's | 130 | | 68 | | 198 | |
| Euc tor | Eucalyptus torquata | Coral gum | Mix B & C | tube | 10 x 8 | 1/m2 | 3 mt c's | | 111 | | | 111 | |
| | , | | | | | | | | | | | | |
| | Screen Shrub Planting | | | | | | | | | | | | |
| Aca aci | Acacia acinacea | Gold-dust Wattle | Mix A & B | tube | 3 x 3 | 1/m2 | | 151 | 162 | | | 313 | |
| | Acacia decora | Western golden wattle | Mix A & B | tube | 3 x 2 | 1/m2 | | 151 | 162 | | | 313 | |
| Aca bra | Acacia brachybotrya | Grey Wattle | Mix B & C | tube | 4 x 3 | 1/m2 | | | 162 | 136 | | 298 | |
| Aca ite | Acacia iteaphylla | Flinders ranges wattle | Mix A, C & D | tube | 2 x 3 | 1/m2 | | 151 | | 136 | 138 | 425 | |
| | Acacia montana | Mallee Wattle | Mix A & D | tube | 2 x 3 | 1/m2 | | 151 | | | 138 | 289 | |
| Aca pen | Acacia pendula | Boree | Mix A & B | tube | 6 x 6 | 1/m2 | | 151 | 162 | | | 313 | |
| Aca pyc | Acacia pycnantha | Golden Wattle | Mix B | tube | 4 x 2 | 1/m2 | | | 162 | | | 162 | |
| | Bursaria spinosa ssp. spinosa | Sweet Bursaria | Mix C | tube | 2 x 3 | 1/m2 | | | | 136 | | 136 | |
| Cal bra | Callistemon brachyandrus | Prickly bottlebrush | Mix A & C | tube | 3 x 3 | 1/m2 | | 151 | | 136 | | 287 | |
| Cal cit | Callistemon citrinus | Crimson bottlebrush | Mix C | tube | 3 x 3 | 1/m2 | | | | 136 | | 136 | |
| Cal sal | Callistemon salignus | White weeping bottlebrush | Mix A | tube | 3 x 3 | 1/m2 | | 151 | | | | 151 | |
| Hak lau | Hakea laurina | Pin cushion hakea | Mix A, B & C | tube | 4 x 4 | 1/m2 | | 151 | 162 | 136 | | 449 | |
| Mel dec | Melaleuca decussata | Totem poles | Mix A & B | tube | 2 x 3 | 1/m2 | | 151 | 162 | | | 313 | |
| Mel lan | Melaleuca lanceolata | Moonah | Mix A | tube | 3 x 4 | 1/m2 | | 151 | | | | 151 | |
| Mel lin | Melaleuca linariifolia | Snow-in-summer | Mix B | tube | 5 x 4 | 1/m2 | | | 162 | | | 162 | |
| | Rhagodia spinescens | Hedge saltbush | Mix C & D | tube | 1 x 1 | 1/m2 | | | | 136 | 138 | 274 | |

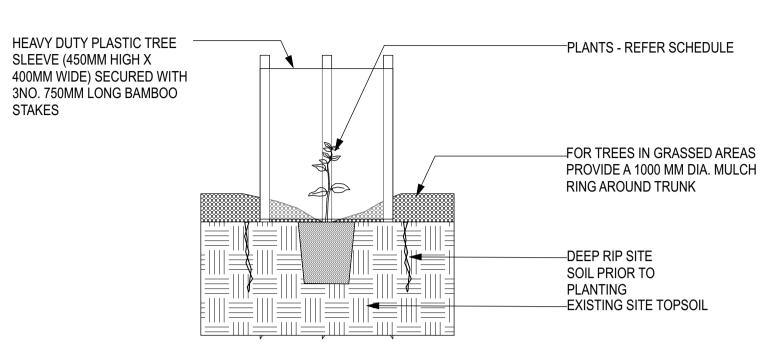





All selected planting is indigenous and should be grown from local provenance stock and supplied by an approved nursery

Tree Protection Notes

- 1. All works within the vicinity of existing trees on the Works site, including works outside of the drip line, must comply in full with AS4970 -2009 Protection of trees on development sites', and the provisions below.
- 2. Where a discrepancy between Provisions arises, Contractors are required to comply in full with the Australian Standard. Any variations to the provisions below or the Standard drawings must be expressly approved by the Superintendent, prior to commencement of any adjustments being undertaken on site.
- 3. Prior to commencing works on site, including preliminary service location, trenching, and site or vegetation clearance; the Contractor shall assess and identify trees that must be protected during the course of the proposed works.
- 4. Tree protection fencing can only be displaced or removed within the project site, with the express permission of the Superintendent.
- 5. Unless otherwise specified or approved by the Superintendent, no trenching, boring, excavation or other ground disturbances associated with utilities or other in-ground services is to be carried out within the Tree Protection Zone as specified in AS4970 -2009 'Protection of trees on development sites'.
- 6. The Contractor must not remove, lop or cut back any trees for storage or access or any other activities associated with the contracted services on site, unless prior approval in writing has been obtained by the Superintendent.
- 7. No persons, vehicles, or machinery shall enter the Tree Protection Zone without the permission of the Superintendent. The Contractor must ensure that the Tree Protection Zone is maintained. Equipment, machinery, vehicles, chemicals, fill, building materials, temporary construction or signage, and other similar items are not permitted within the Tree Protection
- 8. Nothing whatsoever shall be attached to any tree, including temporary services wires, nails, screws or any other fixing

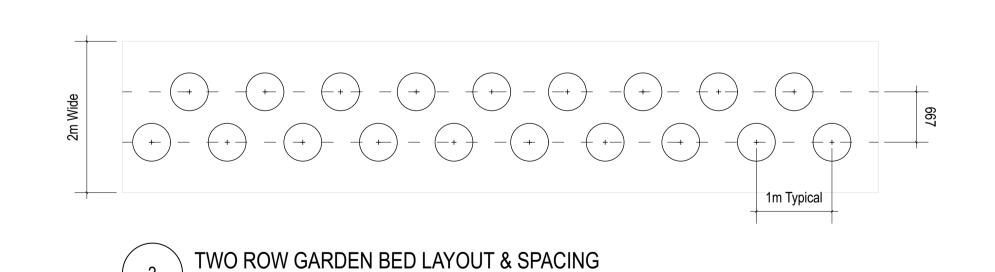

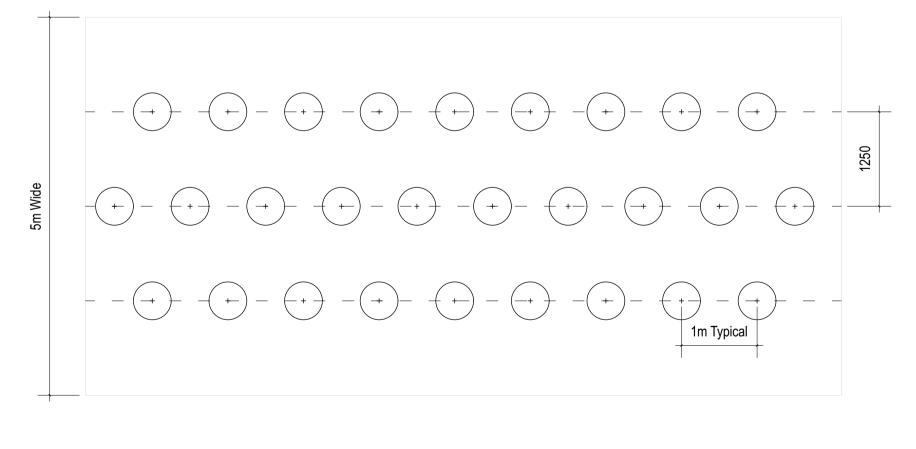

PROJECT

23041

THREE ROW GARDEN BED LAYOUT & SPACING Scale: 1:50

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Scale: 1:50

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CAD FILE

NAME

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STAKES

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Deiniliquin Micro Solar Farm

Planting Schedule & Details

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